



TACTILE PAVING PLAN AT UNCONTROLLED PEDESTRIAN CROSSINGS.

SCALE: 1:50

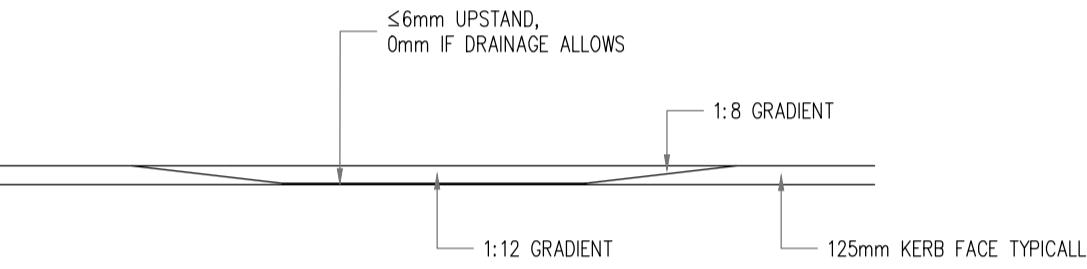




TACTILE PAVING ELEVATION.

SCALE: 1:50

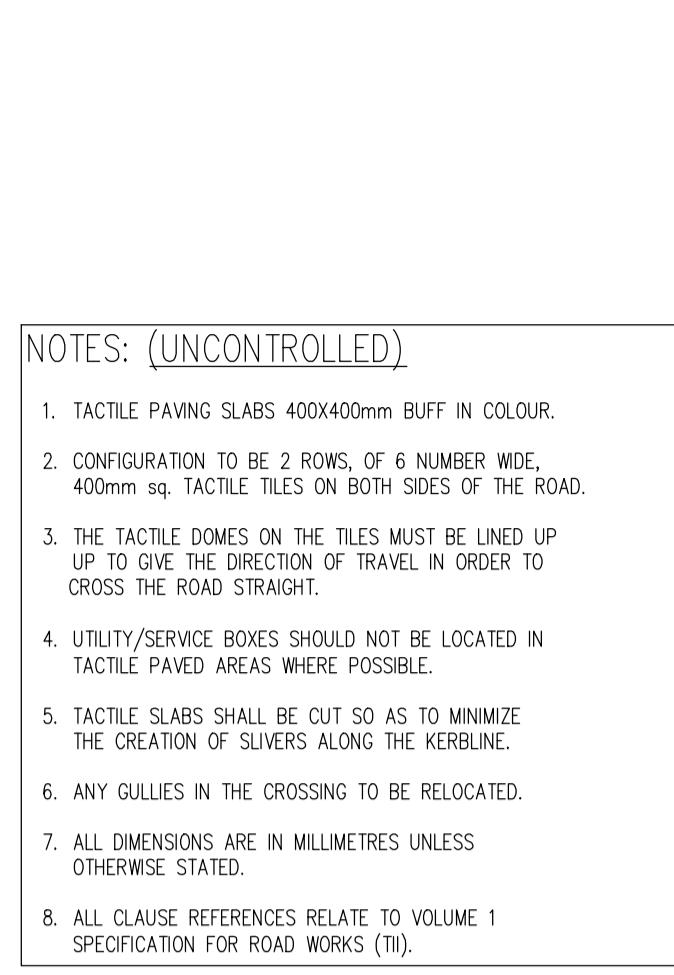


NOTE:

1. All dimensions in millimetres unless stated otherwise.
2. All steelwork to be grade S235 J2 in accordance with ISEN 2899-1.
3. All steelwork to be hot-dip galvanized in accordance with ISEN ISO 1461.
4. Check the underground services at an early stage (and accommodate as may be necessary).
5. Refer to traffic sign manual for all standard dimension.
6. Post embedment to be 0.75x0.
7. Orientation of sign:
  - On a straight road - horizontal axis 90° away from the general alignment of the left-hand side of the carriageway.
  - On a right-hand bend - 90° angle to a line tangential to the left-hand edge of carriageway.
  - On a left-hand bend - 95° from a line joining the edge of carriageway 200m in advance of the sign.
8. All clause references relate to volume 1 specification for road works (III).

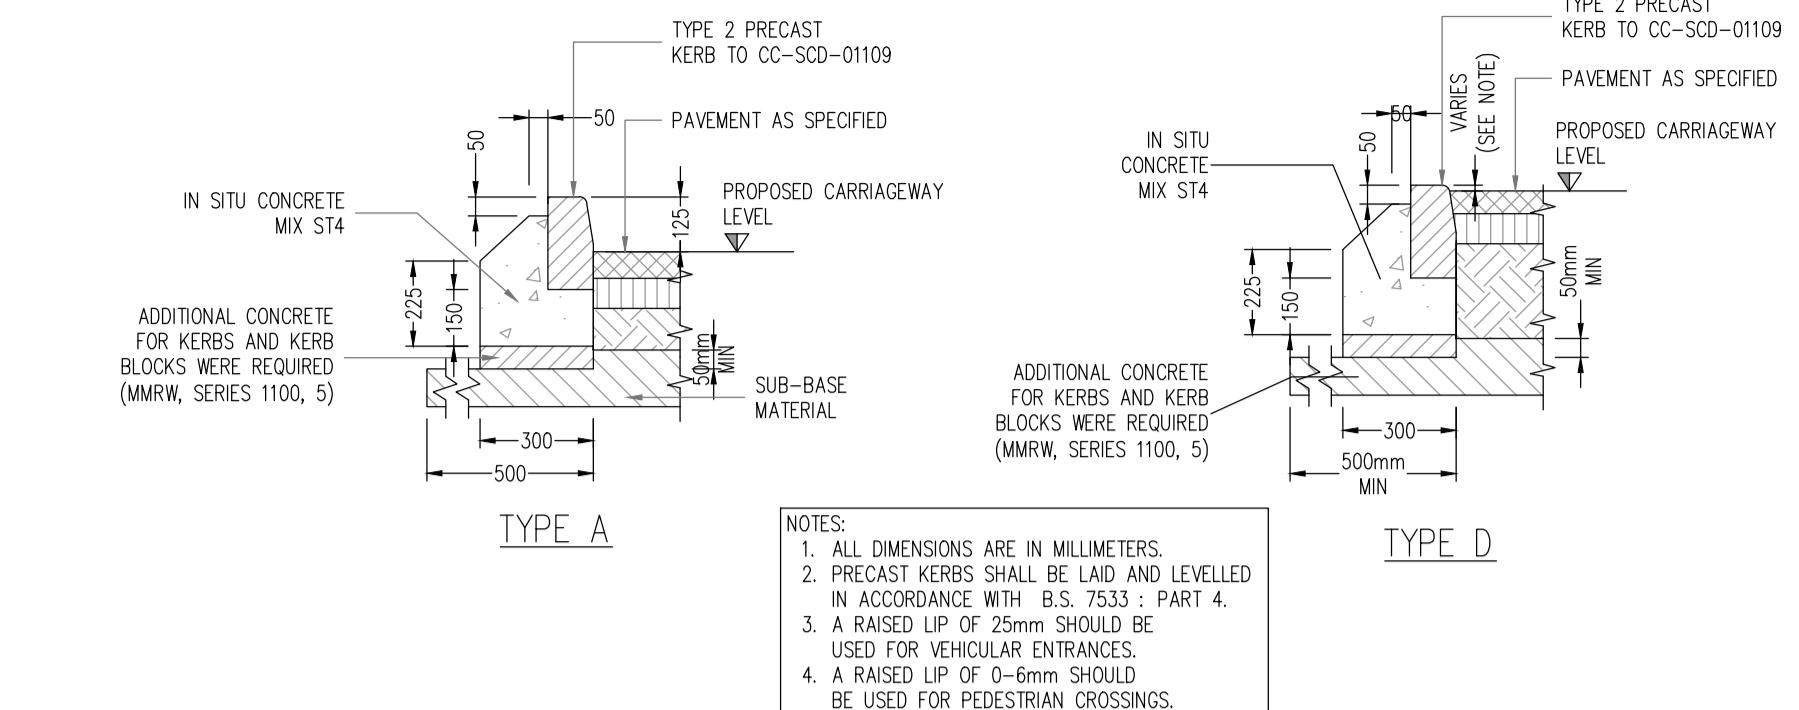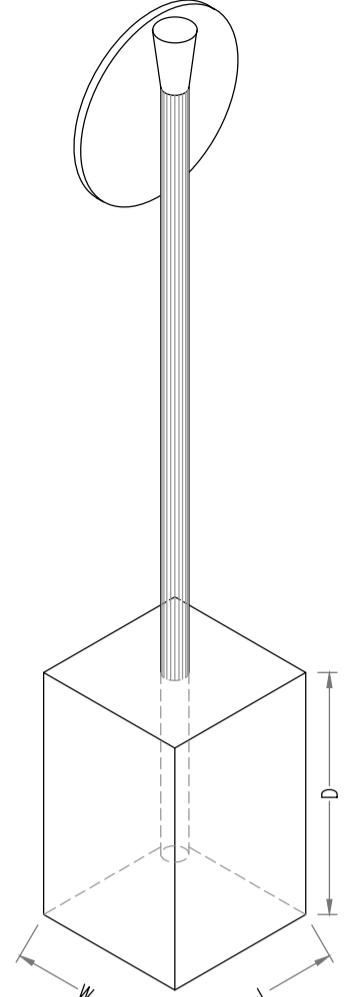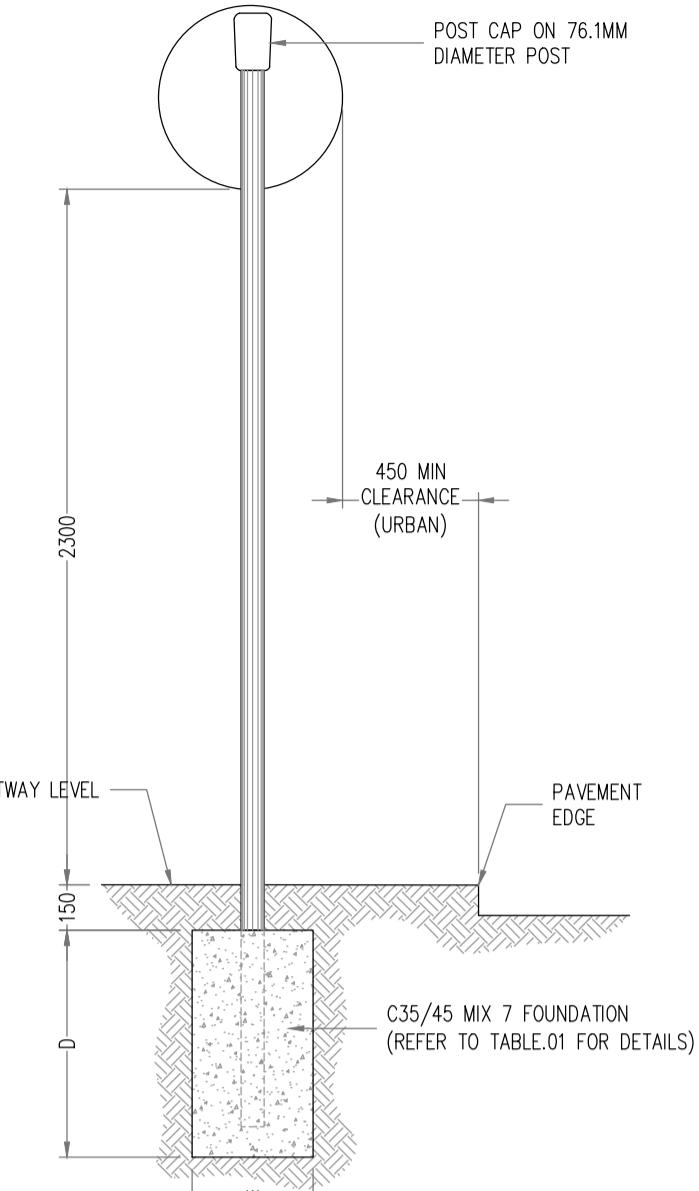



PRECAST KERBS CC-SCD-01101

SCALE: 1:20

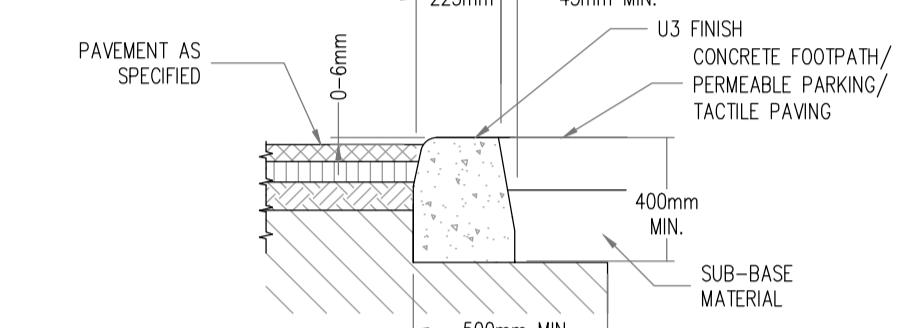


0-6MM KERB DETAIL

SCALE: 1:20

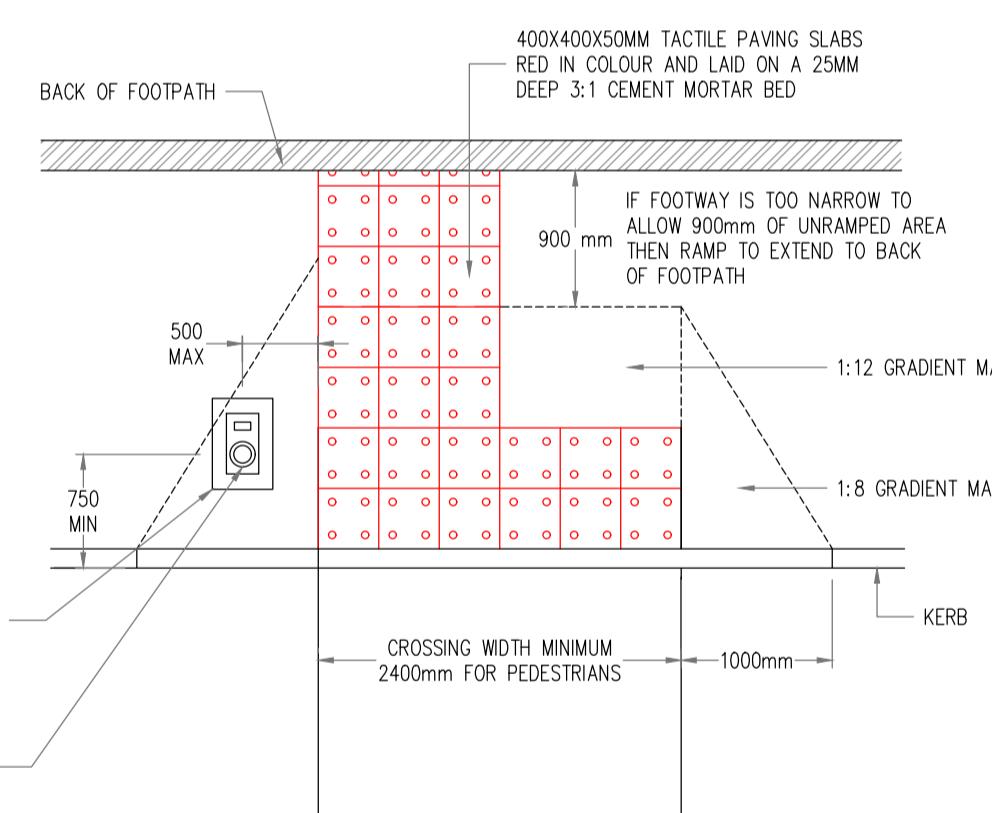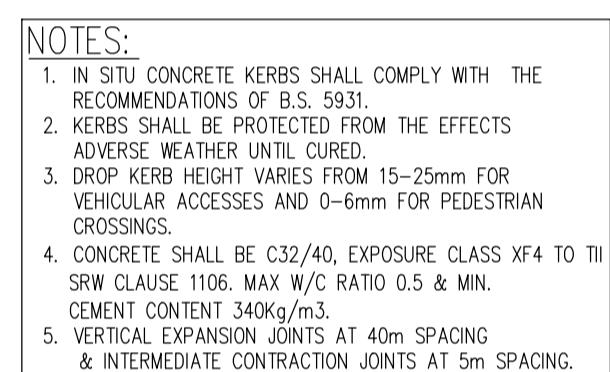


TACTILE PAVING PLAN AT CONTROLLED PEDESTRIAN CROSSING.

SCALE: 1:50

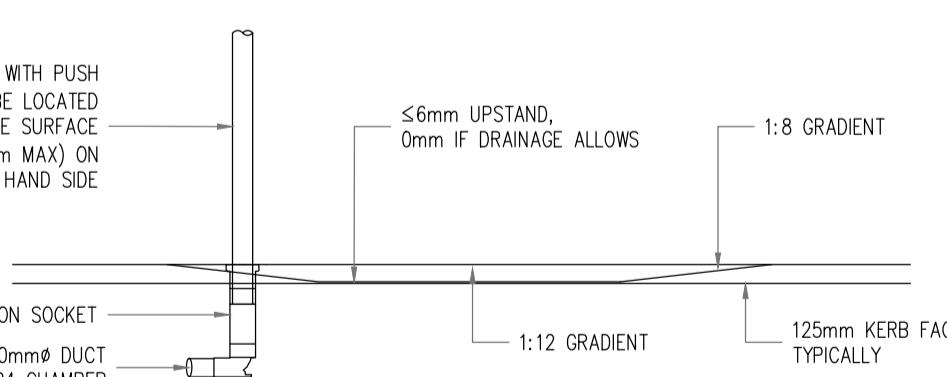


TACTILE PAVING ELEVATION.

SCALE: 1:50

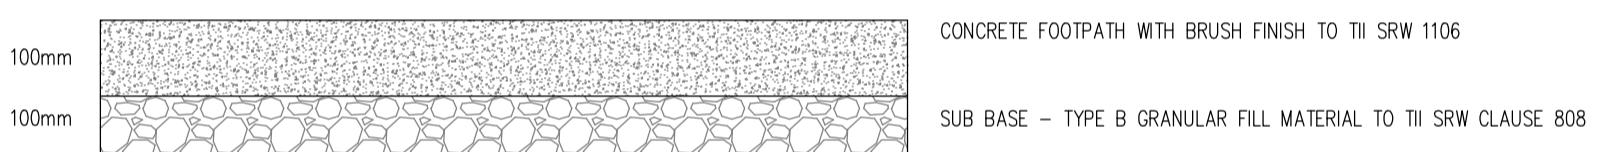


TYPICAL CONCRETE FOOTPATH CONSTRUCTION

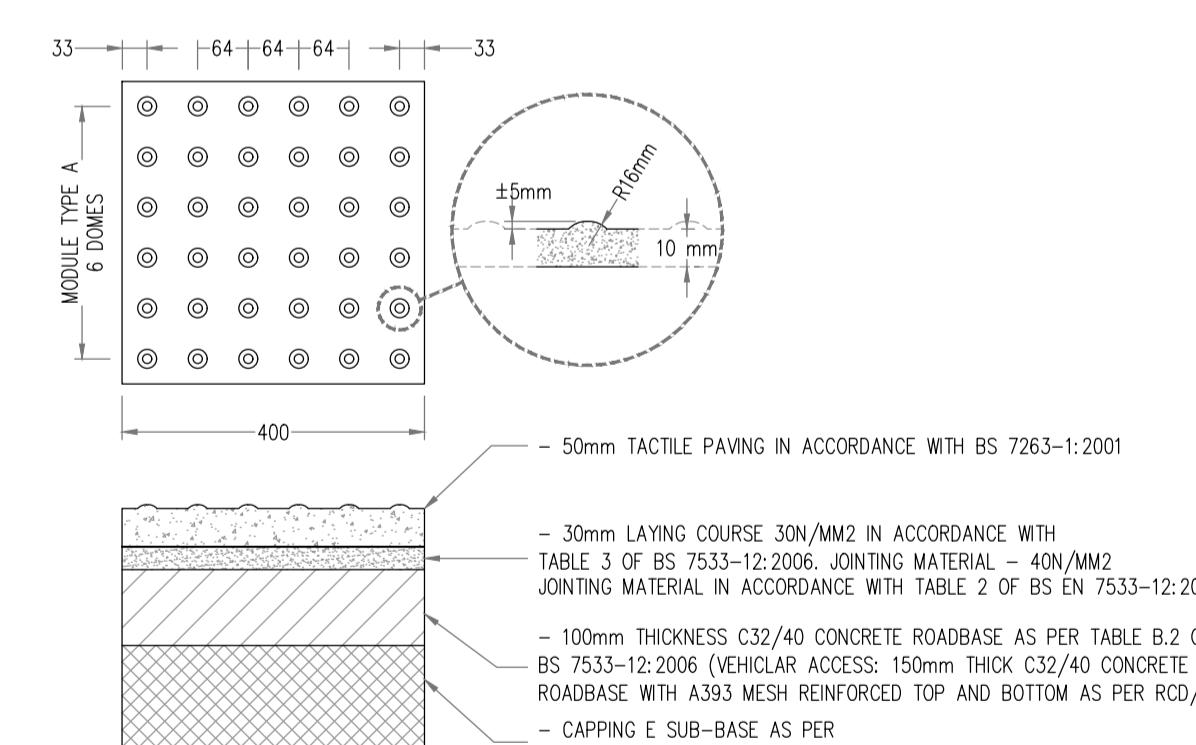

TACTILE PAVING AT CONTROLLED/UNCONTROLLED PEDESTRIAN CROSSINGS.

(LANDSCAPE ARCHITECT'S REFERENCE: P11)

SCALE: 1:10

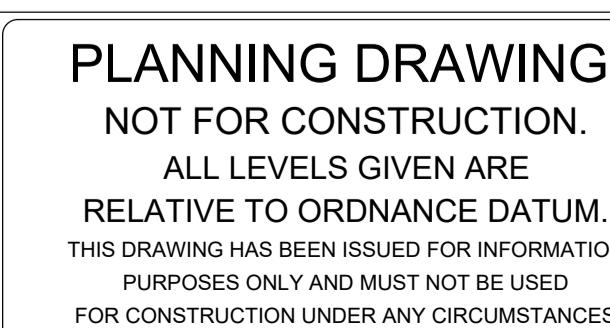

NOTES

1. For setting out refer to Architect's drawings.
2. This drawing to be read in conjunction with all other Architectural and Engineering drawings and all other relevant drawings and Specifications.
3. DO NOT SCALE THIS DRAWING. Use figured dimensions only.
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REV	DESCRIPTION	DRN. BY	CHK. BY	DATE	PROJECT	ANGLESEA TERRACE
P01	ISSUED FOR PRE-PLANNING	JS	LJ	20.06.2025	CLIENT	LAND DEVELOPMENT AGENCY (LDA)
P02	ISSUED IN DRAFT FOR LEGAL REVIEW	JS	LJ	15.09.2025	JOB No.	H105
P03	PRE PART-8 ISSUE	JS	LJ	09.10.2025	DRAWING No.	H105-CSC-XX-XX-DR-C-0010
					STATUS	SUITABLE FOR INFORMATION
					DRAWN BY	JS
					CHECKED BY	PO3
					SCALE	AS SHOWN @ A1
					REVISION	APR 2025

